



A1.0

PERMIT DRAWINGS

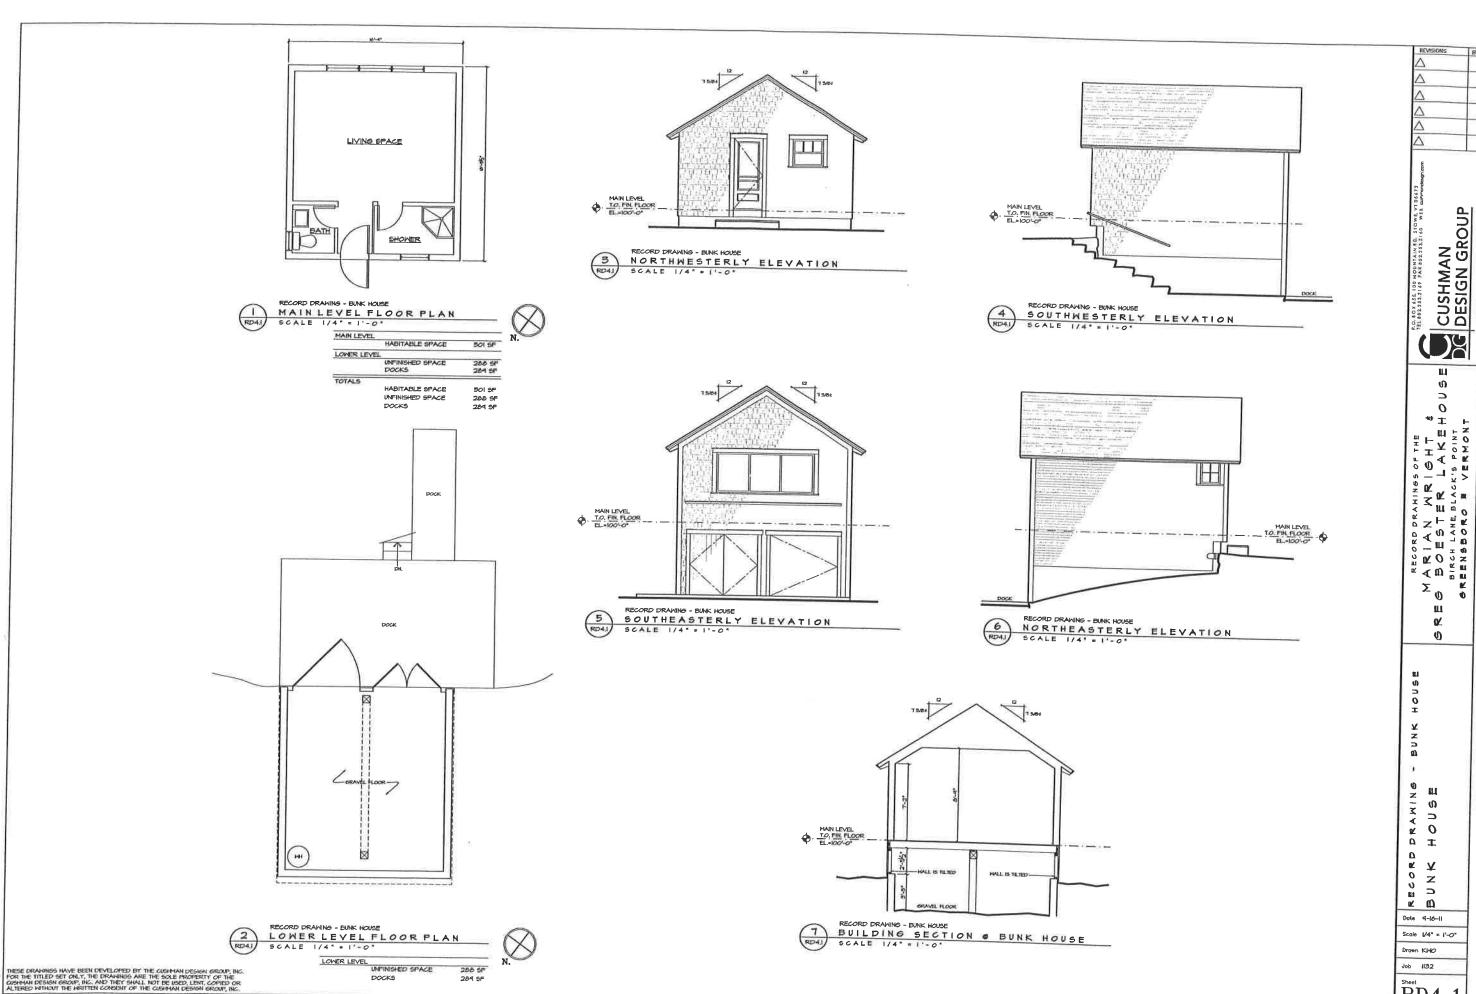

RECORD DRAWING

RD4.1

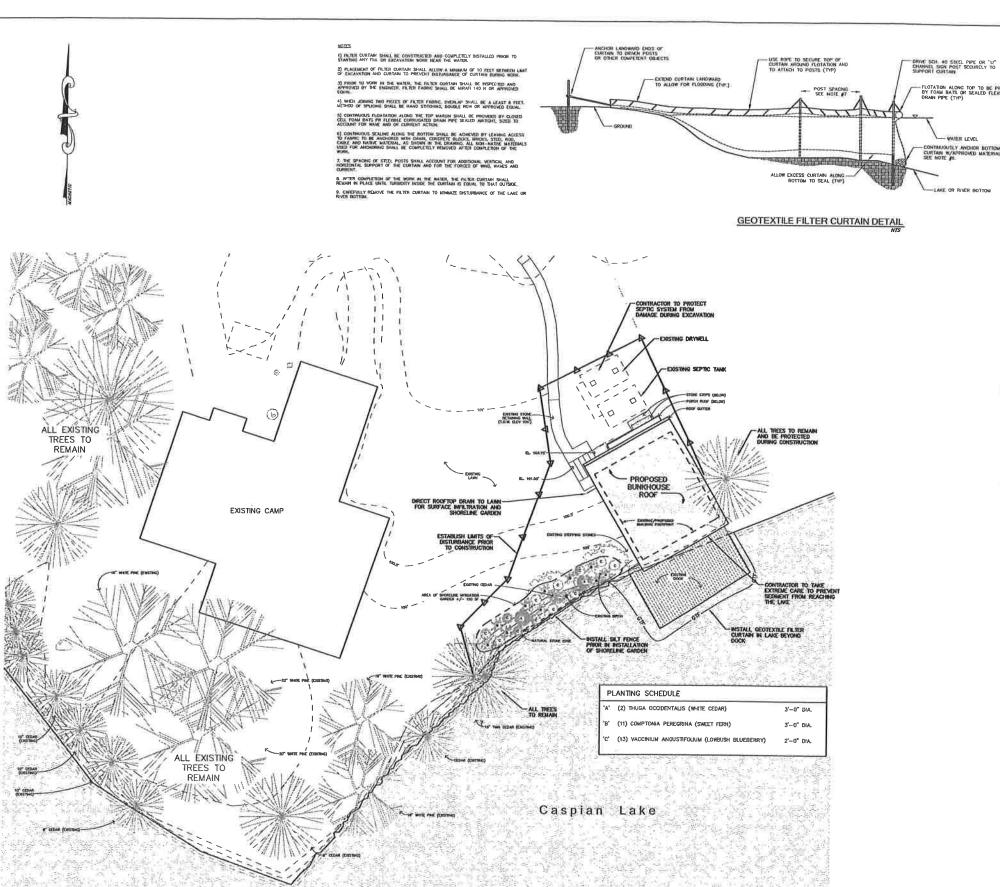

GRAPHIC SCALE

( IN FEET )

**EPSC LEGEND** 

- GTF---

- SILT FENCE

-- GEOTEXTILE FILTER

## **EROSION CONTROL NOTES**

L. PROPERTY LINES SHOWN ON THESE PLANS ARE BASE UPON SURVEYS PROVIDED BY OTHERS. THE PROJECT VERTICAL DATUM IS USES. TOPGGRAPHY AND EXISTING CONTOURS OF THE AREA SHOWN ON THE SITE PLANS WERE DEVELOPED BY FIELD SURVEYS.

#### TEMPORARY & PERMANENT PLANTINGS, SOIL AMENDMENTS

2 ALL DISTURBED AREAS SHALL BE SEEDED AND MULCHED IN THE FOLLOWING PROPORTIONS:
A. SEED © 20 LBYACRE (CONSERVATION MILE)
B. FEITHILIZER (300 LBYACRE OF LOW PHOSPHORUS TYPE)
C. LINE © 2 TONSYACRE
D. MULCH © 2 TONSYACRE

TOPSOIL (3" MINIMUM USING ON SITE STOCKPILES SAVED DURING CONSTRUCTION)
EROSION NETTING (AS NEEDED.)

3. SLT FENCE SHALL BE PLACED AS SHOWN ON THE PLANS TO RETAIN SEDIMENT. THE SLT FENCE CAN BE REMOVED WHEN THE EXCAVATION IS COMPLETE, THE SLOPES ARE MULCHED AND GOOD GRASS COVER STARTED.


4. IT IS ANTICIPATED THAT ADDITIONAL EROSION CONTROL MEASURES WILL BE REQUIRED IN THE FIELD. THE ENGINEER SHALL AUTHORIZE ADDITIONAL HETTING, MULCH, STONE, CULVERTS, ETC. AS THEY BECOME NECESSARY


5. A PRECONSTRUCTION MEETING WILL BE HELD WITH THE OWNER, ENGINEER AND CONTRACTOR TO REVIEW EROSION CONTROL REQUIREMENTS PRIOR TO COMMENCEMENT OF CONSTRUCTION.

7. MAINTENANCE AND INSPECTIONS: INSPECTIONS TO BE PERFORMED A MINIMUM OF ONCE PER WEEK, ALSO, PRIOR TO AND IMMEDIATELY FOLLOWING STORM EVENTS. MAINTENANCE TO BE PERFORMED AS NEEDED BASED ON INSPECTIONS.

B. ALL SEED SHALL BE APPLIED PRIOR TO SEPTEMBER 15TH, TO FACILITATE GERMINATION.

9. ONSITE COORDINATOR FOR WRIGHT & BOESTER IS DONNIE BLAKE CONSTRUCTION.

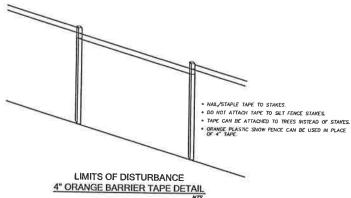

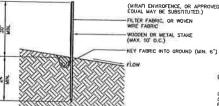

### CONSTRUCTION SPECIFICATIONS FOR SILT FENCE.

SILT FENCE SHALL BE ETHER PRE-FABRICATED ENDSIGN CONTROL FENCE (WIRAT) ENVIROFENCE, OR EQUAL), OR CONSTRUCTED-IN-PLACE, AS SPECIFIED HERBIN.

### PRE-EARHICATED SILT FENCE

NOTE: ORIGINAL PLAN 24 " x 36 ", OTHER SIZES NOT TO SCALE

NOTE EXISTING BASE DRAWING & TOPOGRAPHICAL FEATURES

PROVIDED BY CUSHMAN DESIGN GROUP AND WERE NOT SURVEYED/FIELD VERIFIED BY THIS OFFICE.

1) FENCE SHALL BE INSTALLED PARALLEL TO GROUPD CONTOURS, AND FILTER FABRIC SDE SHALL FACE UPSLOPE, MESH AND STAKES SHALL FACE OROMSLOPE.

4) BROKEN STAKES SHALL BE REPLACED PROMPYLY.

SILT FENCE

# CONSTRUCTED-IN-PLACE SET FENCE

3) WOVEN WIRE FABRIC (14 CA., 6 INCH MAX. MESH OPENING) SHALL HE STAPILED OR FASTENED SECURELY WITH WRE TIES TO UPSLOPE SIDE OF FENCE POSTS. WOVEN WINE FABRIC SHALL EXTEND MINIMUM 36 INCHES ABOVE GRADE.

4) FILTER FABRIC SHALL BE FASTENED SECURELY ON UPSLOPE SIDE OF WOVEN MIRE PARRIEW WITH MIRE TIES, SPACED EVERY 24 INCHES, AT TOP AND MID—SECTION OF FERICE. MINIMUM 8 INCH FLAP OF FILTER FABRIC SHALL BE PLACED IN TRENCH ON UPSLOPE SIDE OF FERICE, SHALL BE PLACED IN TRENCH ON UPSLOPE SIDE OF FERICE, AND

5) WHEN TWO SECTIONS OF FABRIC ADJOIN EACH OTHER, THEY SHALL BE OVERLAPPED BY 6 INCHES, FOLDED AND STANKED


6) SILT FENCE SHALL BE INSPECTED WEEKLY, AND AFTER EACH SIGNIFICANT PRECIPITATION EVENT. MAINTENANCE SHALL BE FEHFORMED AS NELDED, AND SEDMENT REMOVED WHEN "BULGES" DEVELOP IN SILT FENCE.

**EPSC PLAN & DETAILS** 


WRIGHT & BOESTER

151 BIRCH LANE **GREENSBORO** P.O. Box 445 GRENIER aterbury VT 05078 ENGINEERING, PC 155 DEMERITT PLACE #2


X/TJM 1" = 6" TEL (802) 244-6413 Sheet No: 1 of 1 FAX (802) 244-1572 wg Name: EPSC PLAN

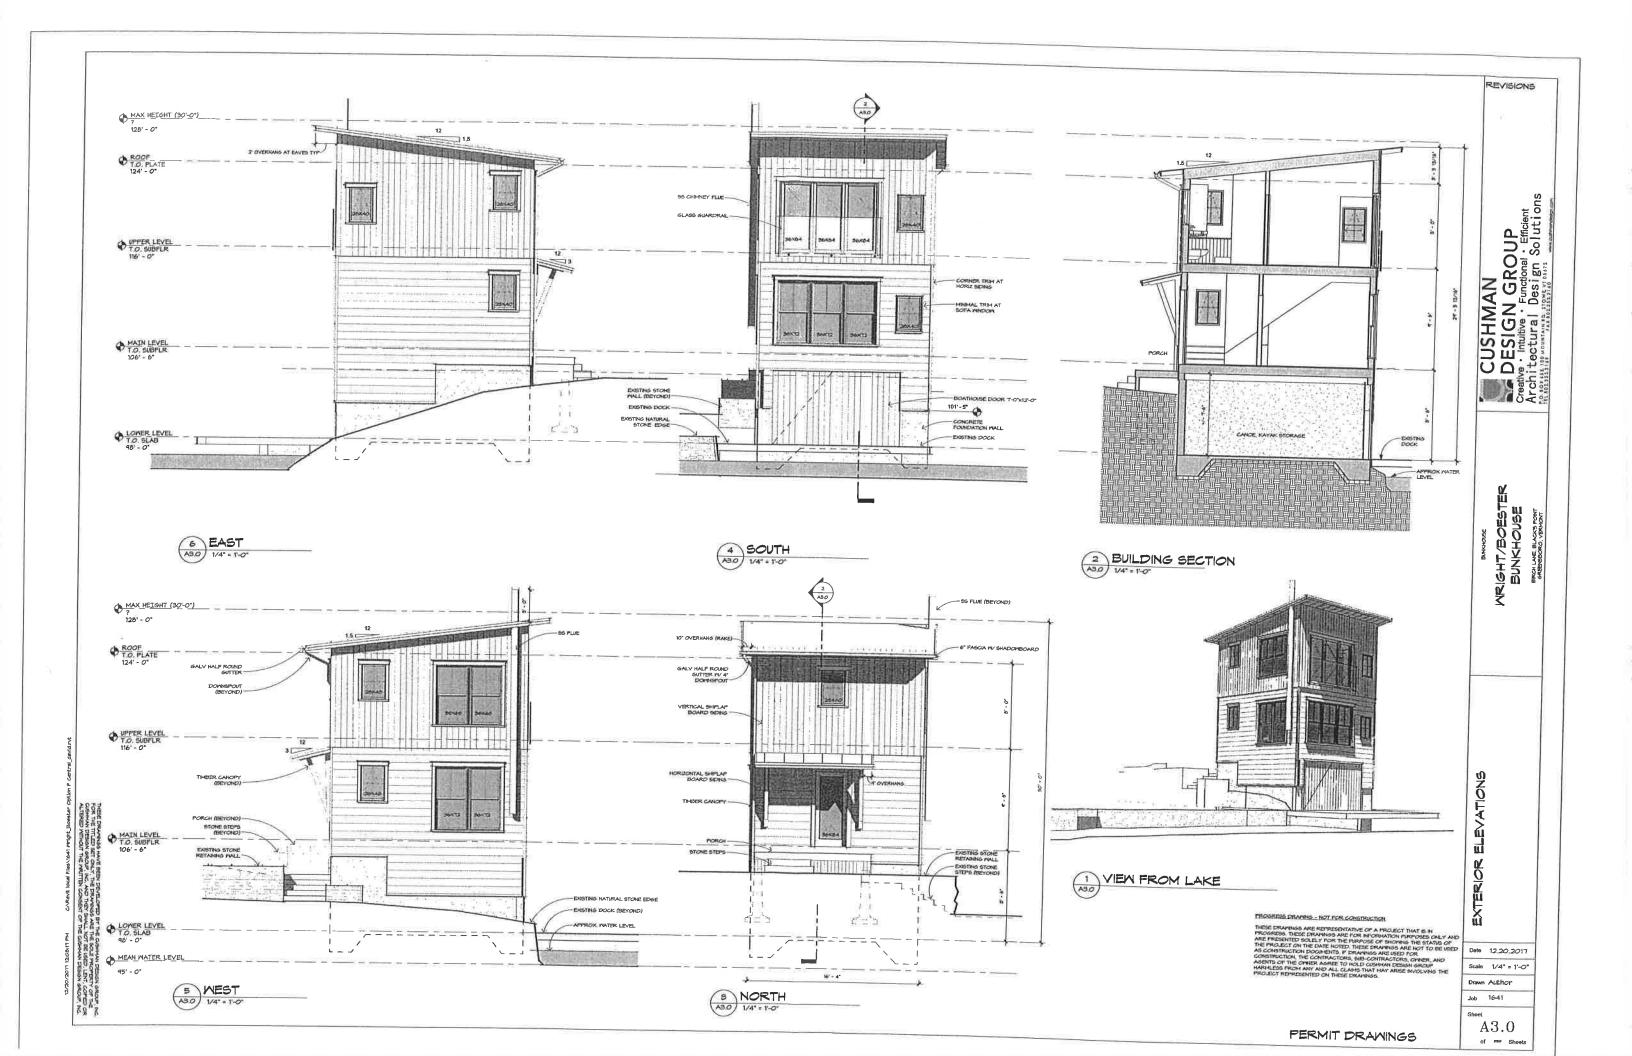

B UPPER LEVEL FLOOR PLAN

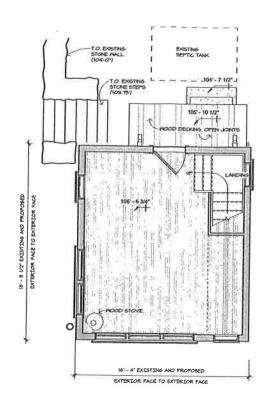

MAIN LEVEL FLOOR PLAN

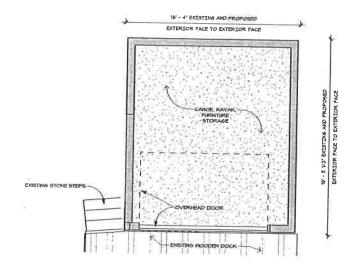

1 LOWER LEVEL FLOOR PLAN

PROGRESS DRAWING - NOT FOR CONSTRUCTION

Date 12.20.2017 Scale 1/4" = 1'-0"

PERMIT FLOOR PLANS

Drewn Author Job 16-41

REVISIONS

CUSHMAN

DESIGN GROUP

Creative - Intuitive - Functional - Efficient
Architectural Design Solutions
(Canal Solutions)
(C

MRIGHT/BOESTER BUNKHOUSE

Sheet A2.0 of #text Sheets

PERMIT DRAWINGS